


AERATED LAGOON FACILITY IMPROVEMENTS DILLINGHAM, ALASKA

ISSUED FOR CONSTRUCTION (100% SUBMITTAL)
APRIL 2019

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LOCATION MAP

NOT TO SCALE

VICINITY MAP

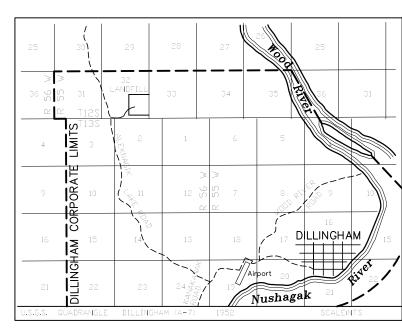NOT TO SCALE

ALASKA MAP

CHECKED: IPP DRAWN: DKH DATE: APR 2019 SHEET 1 OF 16

SHEET NO.

G1.0

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Bristol

ENGINEERING
SERVICES COMPANY, LLC


111 W. 16th Avenue, Third Floor
Anchorage, AK 99501
Phone (907) 563-0013 Fax (907) 563-6713
Llcense Number: AECC697





AERATED LAGOON FACILITY IMPROVEMENTS
DILLINGHAM, ALASKA

TITLE SHEET, LOCATION AND VICINITY MAPS,
AND SHEET INDEX

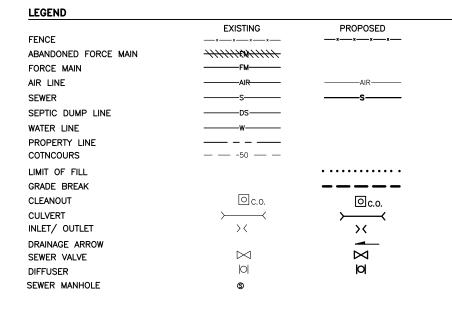

NOTES:

- MULTIPLE SURVEY DATA SOURCES USED FOR PROJECT. ALL ELEVATION DATA IS BASED ON BEST AVAILABLE DATA. FIELD VERIFY BEFORE CONSTRUCTION.
- 2. THE LOCATION OF UTILITIES IS ESTIMATED BASED ON AVAILABLE DATA. RECORD DRAWINGS FOR THE 2018 SEWER MAIN RECONSTRUCTION AND WATER METER MANHOLE WERE NOT AVAILABLE. ALL UTILITIES MUST BE FIELD VERIFIED PRIOR TO CONSTRUCTION.


SUMMARY AND OPERATIONS:

- THE DILLINGHAM LAGOON HAS NOT CONSISTENTLY MET THE PERMIT DISCHARGE REQUIREMENTS.
 THE CURRENT AERATION SYSTEMS HAVE DETERIORATED DUE TO AGE AND DAMAGE. THE
 CURRENT BAFFLE SYSTEMS WERE ALIGNED WITH THE ORIGINAL AERATION EQUIPMENT, AND ARE
 NO LONGER CONNECTED ALONG THE BANK EDGES, ALLOWING SHORT CIRCUITING. A NEW
 AERATION SYSTEM AND ACCOMPANYING BAFFLE SYSTEM DESIGN IS PROVIDED.
- 2. THE NEW AERATION SYSTEM WILL INCLUDE AERATION IN THE SECOND LAGOON CELL, WITH A PORTION OF THE SECOND CELL RESERVED FOR SETTLING PRIOR TO DISCHARGE. THE EXISTING VALVES WITHIN THE BLOWER BUILDING THAT CONTROL AIR FLOW ARE NO LONGER OPERABLE AND MUST BE REPLACED. A NEW AIR HEADER WILL BE INSTALLED FROM THE BLOWER BUILDING TO THE NEW AERATION MANIFOLDS ALONG THE BANK.
- 3. A WASTEWATER HAUL DUMP STATION WAS CONSTRUCTED ALONG THE SOUTH EAST EDGE OF THE LAGOON. THIS REQUIRES A LOADED PUMP TRUCK TO NAVIGATE A DIRT ROAD, DURING POOR CONDITIONS (WINTER SNOW AND ICE, AND BREAKUP). THE CHEMICAL INJECTION SYSTEM IS NOT OPERABLE DURING WINTER MONTHS. THE HAULED WASTEWATER CONSISTS SIGNIFICANTLY OF HOLDING TANK WASTEWATER. WITH A LESSER AMOUNT OF SEPTAGE.
- 4. A NEW PRETREATMENT POND WILL PROVIDE A SAFER, SECURE DUMPING POINT. THE POND IS INTENDED TO PROVIDE A FULL WINTER OF STORAGE. AT THE END OF FALL, THE STOP LOGS IN THE EFFLUENT CONTROL MANHOLE, WILL BE PULLED (ONE STOP LOG PER DAY, OR APPROXIMATELY 17,000 GALLONS PER DAY) TO ALLOW THE FULL DISCHARGE OF THE PRE-TREATMENT POND. THE STOP LOGS WILL THEN BE REINSERTED TO PROVIDE FOR WINTER STORAGE OF WASTEWATER HAUL DUMPING. IN THE SPRING, SUFFICIENT STORAGE WILL BE AVAILABLE TO ALLOW THE MELTING OF THE SHALLOW PRE-TREATMENT POND. THE STOP LOGS WILL MINTAIN A POND DEPTH OF 6.0 FEET. CONTINUOUS DISCHARGE FROM THE POND WILL OCCUR DURING THE NON-WINTER MONTHS.

ABBREVIATIONS

APPROXIMATE ~ . APROX. ASG ALASKA SAND AND GRAVEL CO CLEANOUT DI DUCTILE IRON DIA DIAMETER DWG DRAWING FT FΜ FORCE MAIN **HDPE** HIGH-DENSITY POLYETHYLENE LF LINEAR FEET MAX MAXIMUM MDD MAXIMUM DRY DENSITY MG MILLIGRAMS MIN MINIMUM NTS NOT TO SCALE SCH **SCHEDULE** SS, SST STAINLESS STEEL TYP TYPICAL PΕ **POLYETHYLENE** CU COPPER

SECTIONS AND DETAIL DESIGNATION

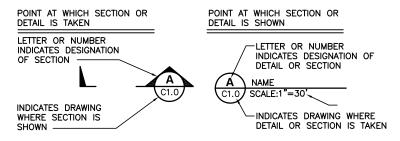

REFERENCE TO DETAILS AND SECTIONS ARE ALSO DESIGNATED BY X/A-Y, WHERE X IS A NUMBER FOR DETAILS AND A LETTER FOR SECTIONS, AND A-Y IS THE DRAWING ON WHICH THE SECTION OR DETAIL APPEARS

LAGOON DESIGN CRITERIA

POPULATION

DILLINGHAM POPULATION – SUMMER 7,000
DILLINGHAM POPULATION – WINTER 2,250
WASTEWATER SERVICE CONNECTIONS 235

<u>LAGOON</u>

AVERAGE WASTEWATER FLOW RATE 150,000 GALLONS PER DAY NUMBER OF CELL 2 AVERAGE LAGOON AREA (PER CELL) 1.5 **ACRES** MINIMUM FREEBOARD DEPTH FEET 2 FEET LAGOON ACTIVE DEPTH 18 LAGOON VOLUME (TOTAL) 9,000,000 GALLONS AVERAGE RESIDENT TIME 60 DAYS

INFLUENT AVERAGE
-BIOCHEMICAL OXYGEN DEMAND (BOD) 150 MG/L

INFLUENT AVERAGE

-TOTAL SUSPENDED SOLIDS (TSS) 16 MG/L

AVERAGE BOD LOADING 125 POUNDS/ACRE DAY

HAULED WASTEWATER*

SUMMER CITY HAUL 2,000 GALLONS PER MONTH
SUMMER PRIVATE HAUL 250,000 GALLONS PER MONTH
TOTAL SUMMER WASTEWATER HAUL 252,000 GALLONS PER MONTH
WINTER PRIVATE HAUL 10,000 GALLONS PER MONTH

*7 NON-FROZEN MONTHS, 5 FROZEN MONTHS ASSUMED

PERMIT STATE OF ALASKA

 -GENERAL WASTEWATER PERMIT
 AKG573004


 DATE ISSUE
 09/01/2018

 DATE EXPIRES
 08/31/2023

EFFLUENT WASTEWATER PERMIT LIMITS*


*PARTIAL LISTING OF KEY CRITERIA

MAXIMUM FLOW PH	273,000 6-9	GALLONS PER DAY
MINIMUM DISSOLVED OXYGEN (DO)	2	MG/L
MAXIMUM AVERAGE BOD (MONTHLY)	30	MG/L
MAXIMUM AVERAGE BOD (MONTHLY)	68	LBS PER DAY
MAXIMUM AVERAGE TSS (MONTHLY)	45	MG/L
MAXIMUM AVERAGE TSS (MONTHLY)	103	LBS PER DAY
MAXIMUM AVERAGE		
FECAL COLIFORM (MONTHLY)	200	FC/100 ML

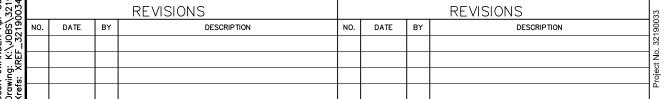





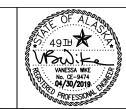

AERATED	LAGOON FACILITY IMPROVEMENT	ſS
	DILLINGHAM, ALASKA	


LEGEND, NOTES, ABBREVIATIONS,

SHEET NO.

AND DESIGN CRITERIA

G1.1

SCALE:SHOWN DESIGNED: VBW CHECKED: IPP DRAWN:DKH DATE: APR 2019 SHEET 2 OF 16

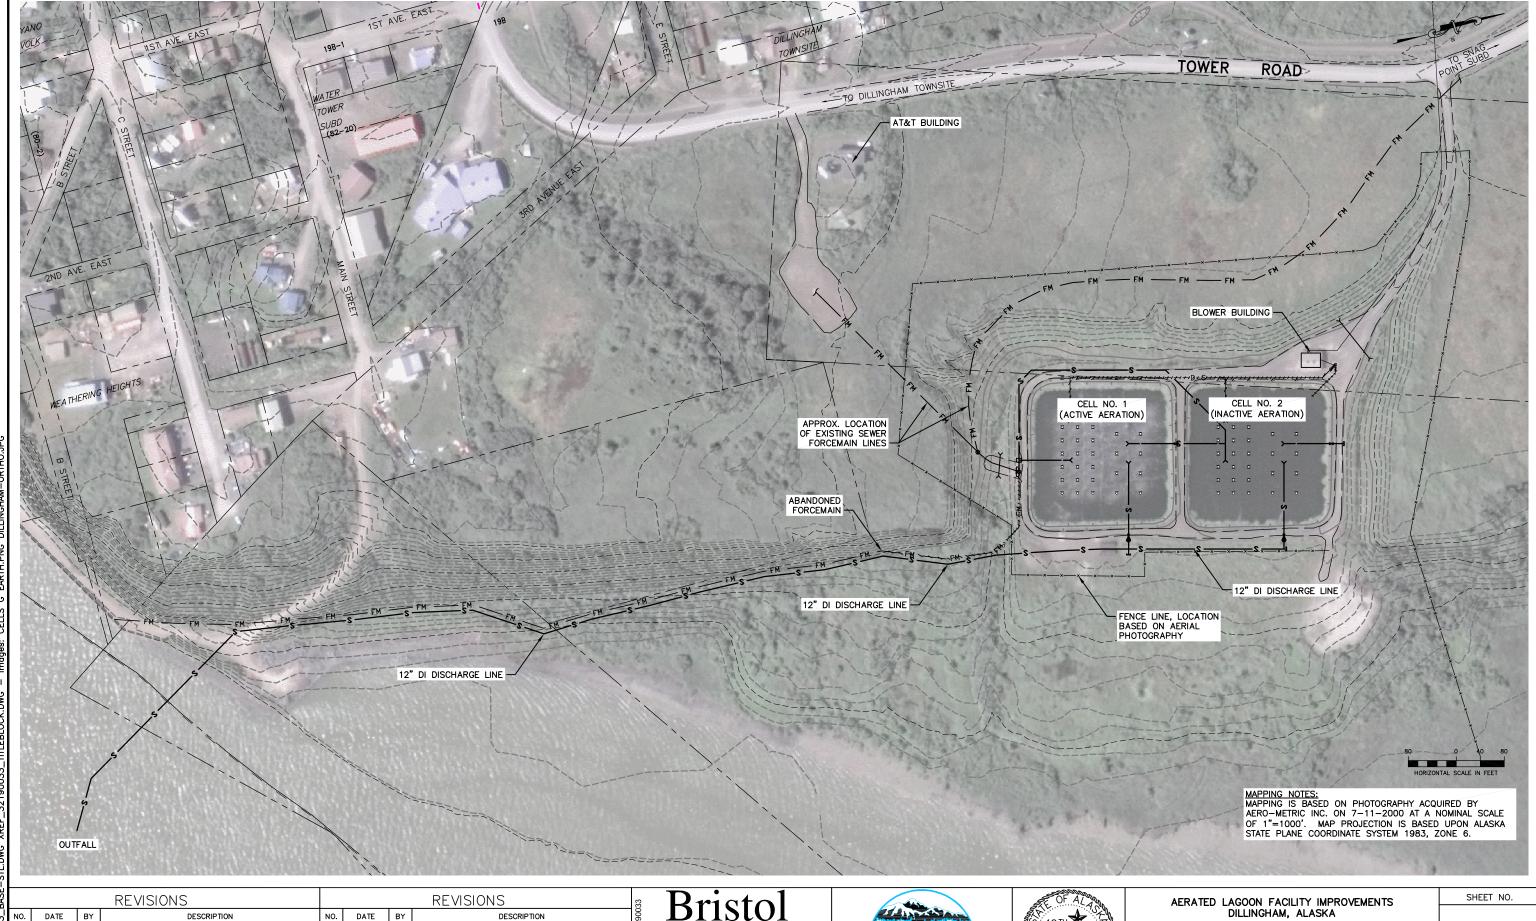

DESCRIPTION

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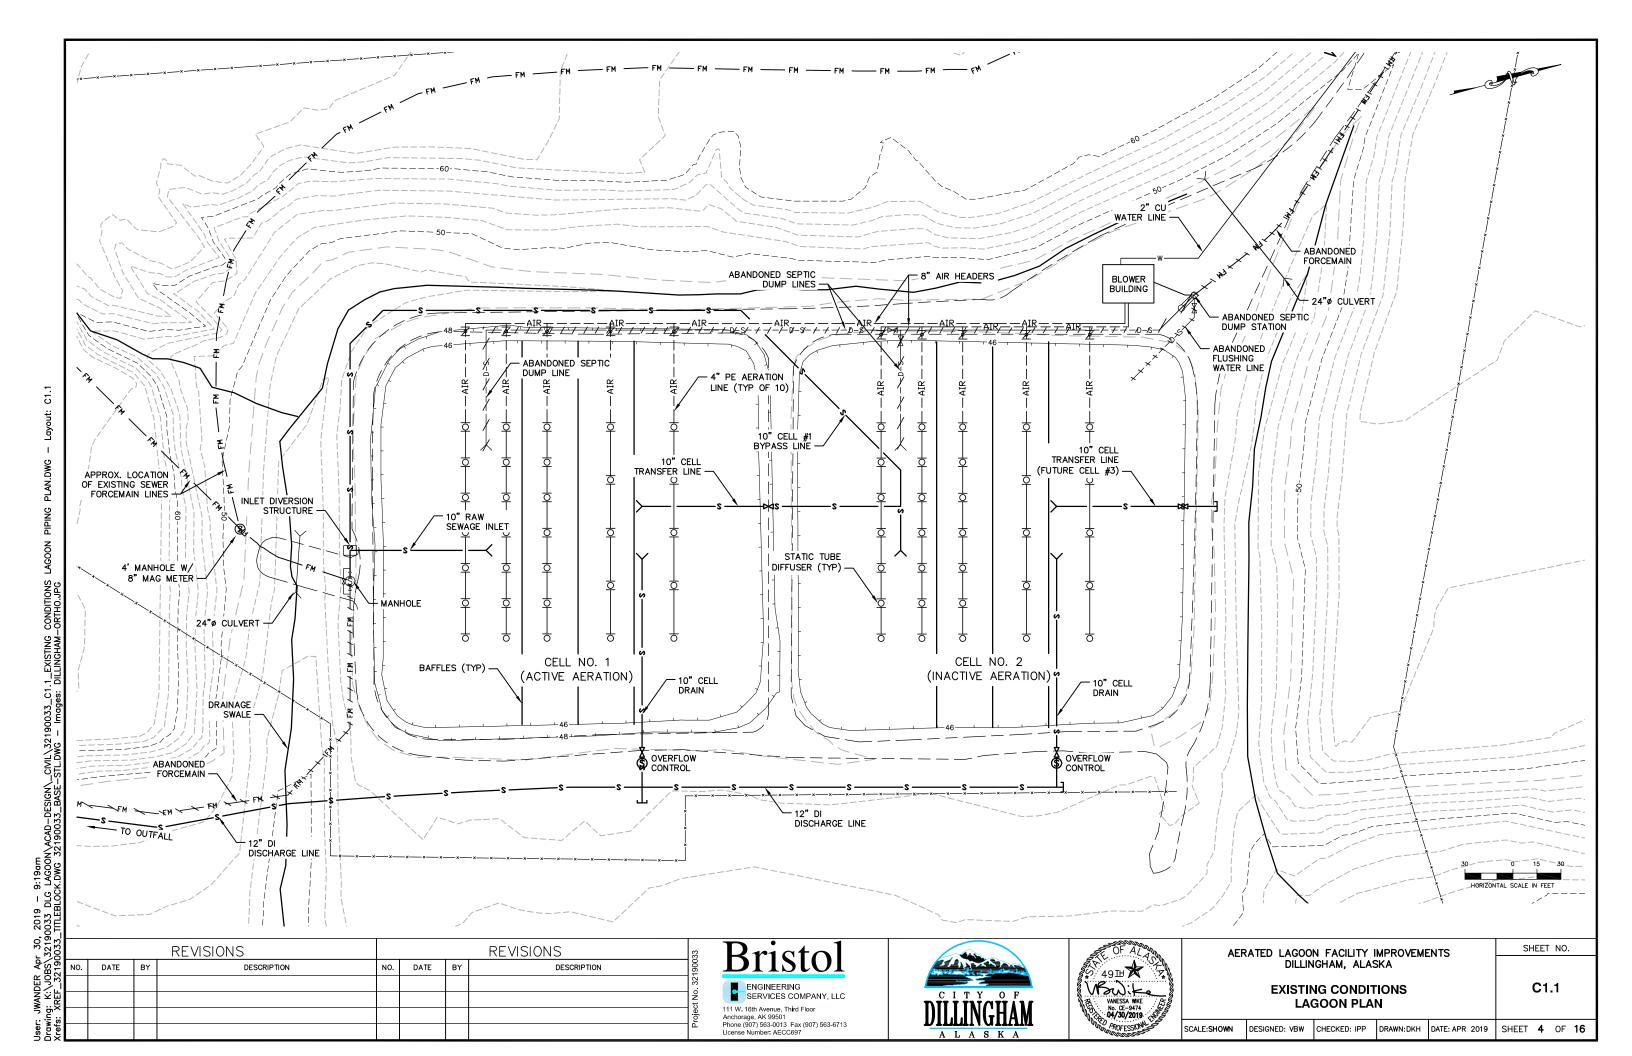



EXISTING CONDITIONS SITE PLAN


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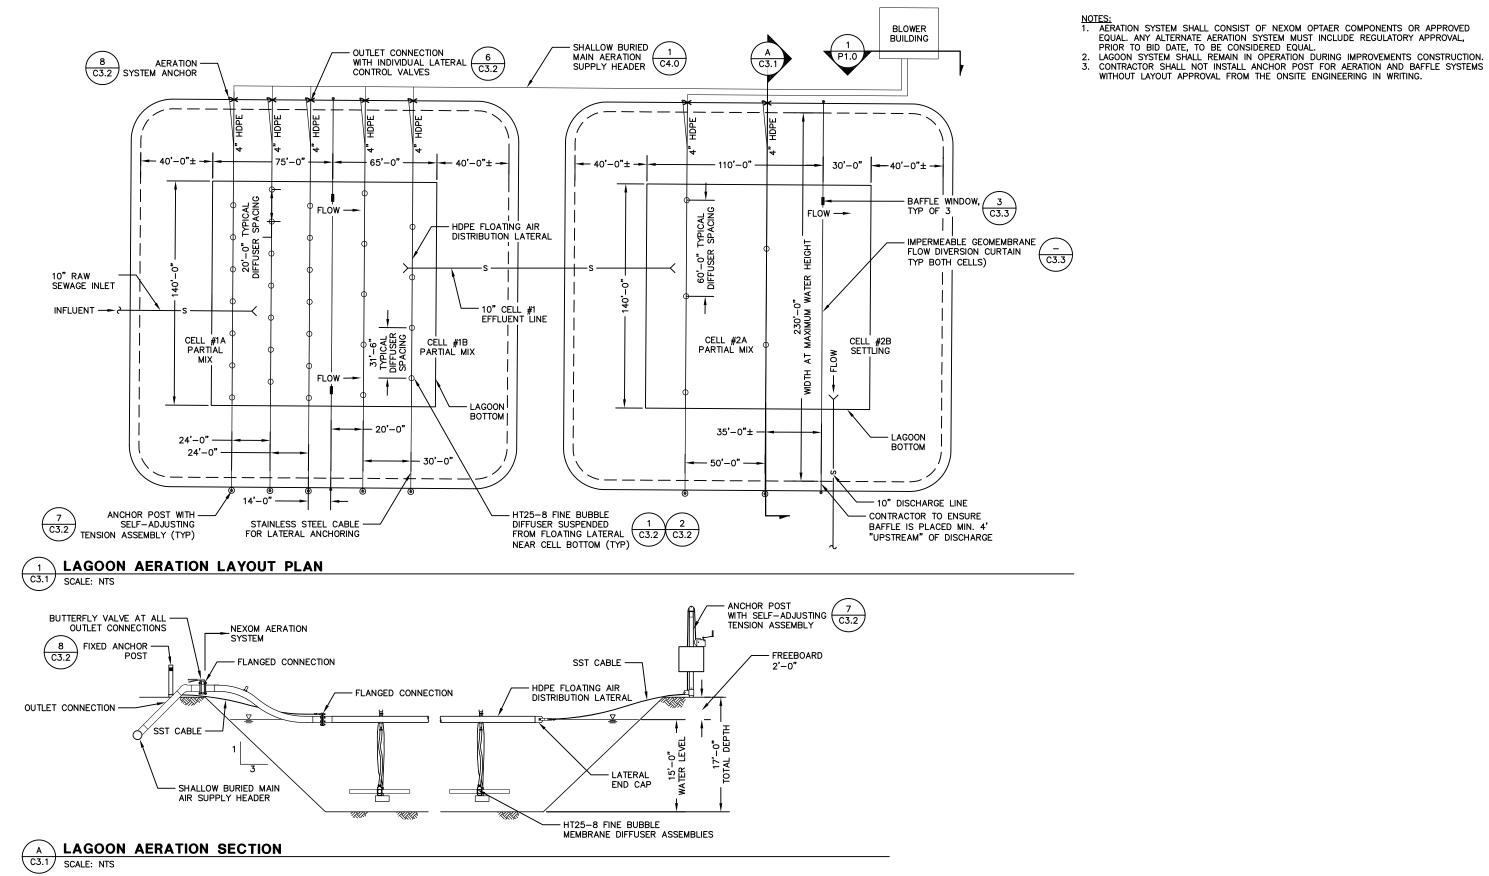
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C1.0








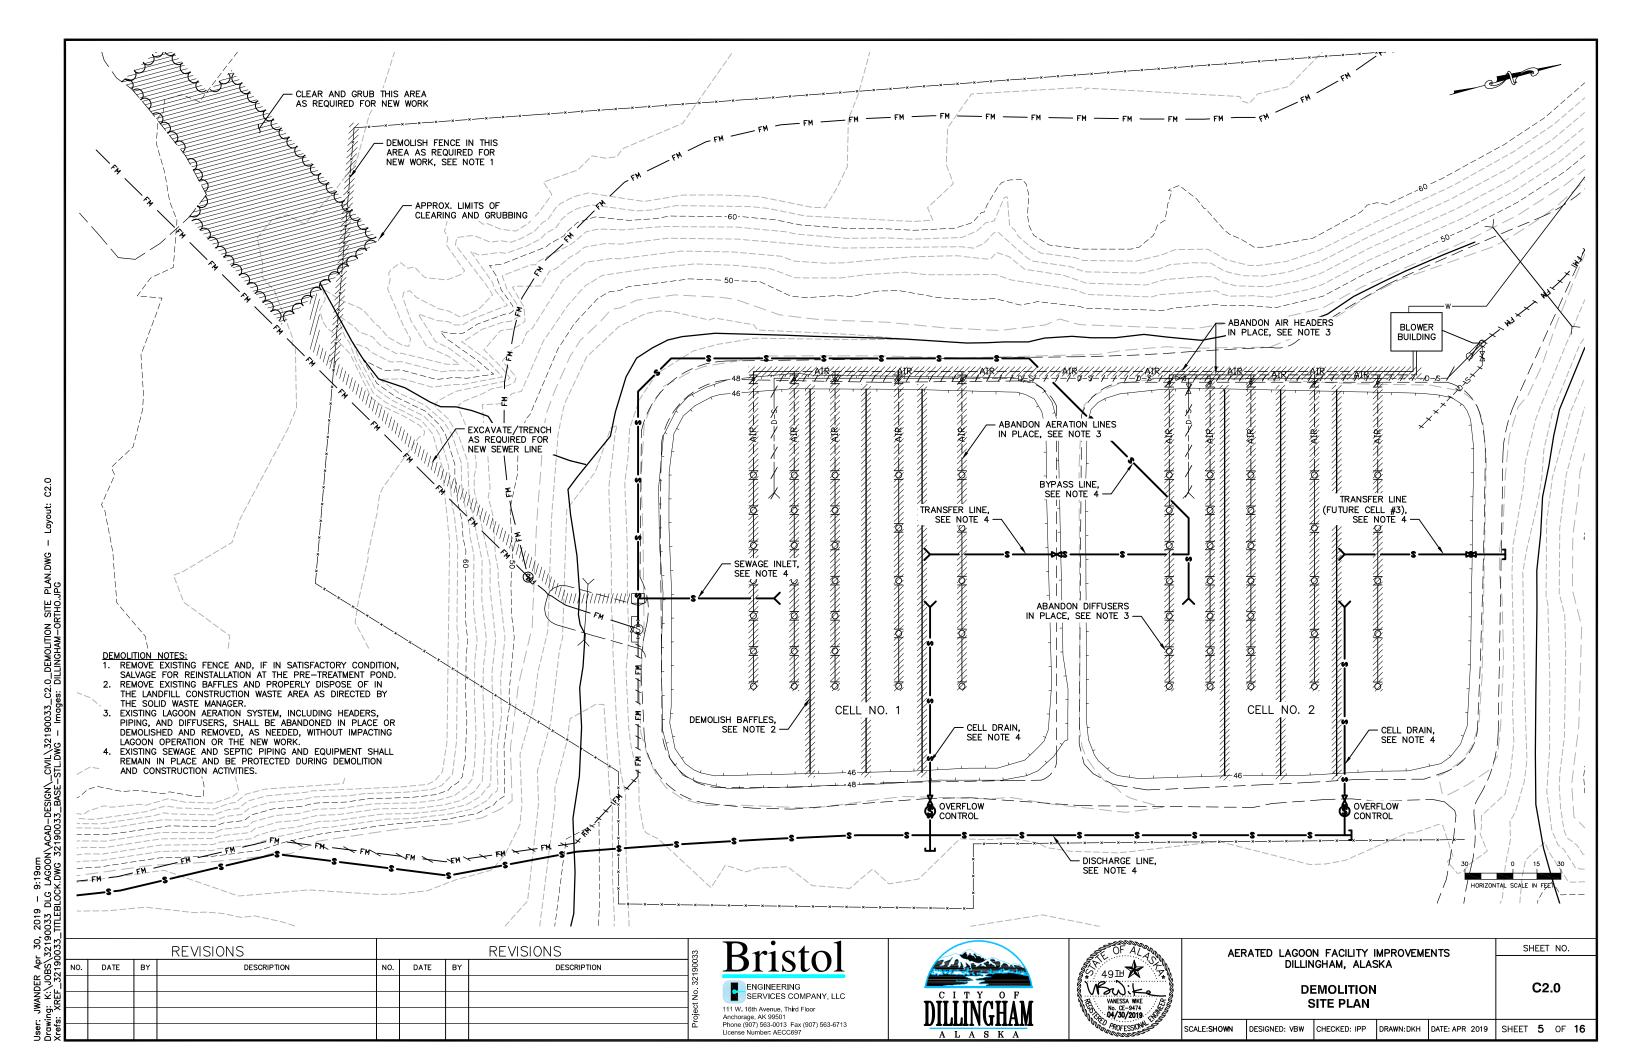
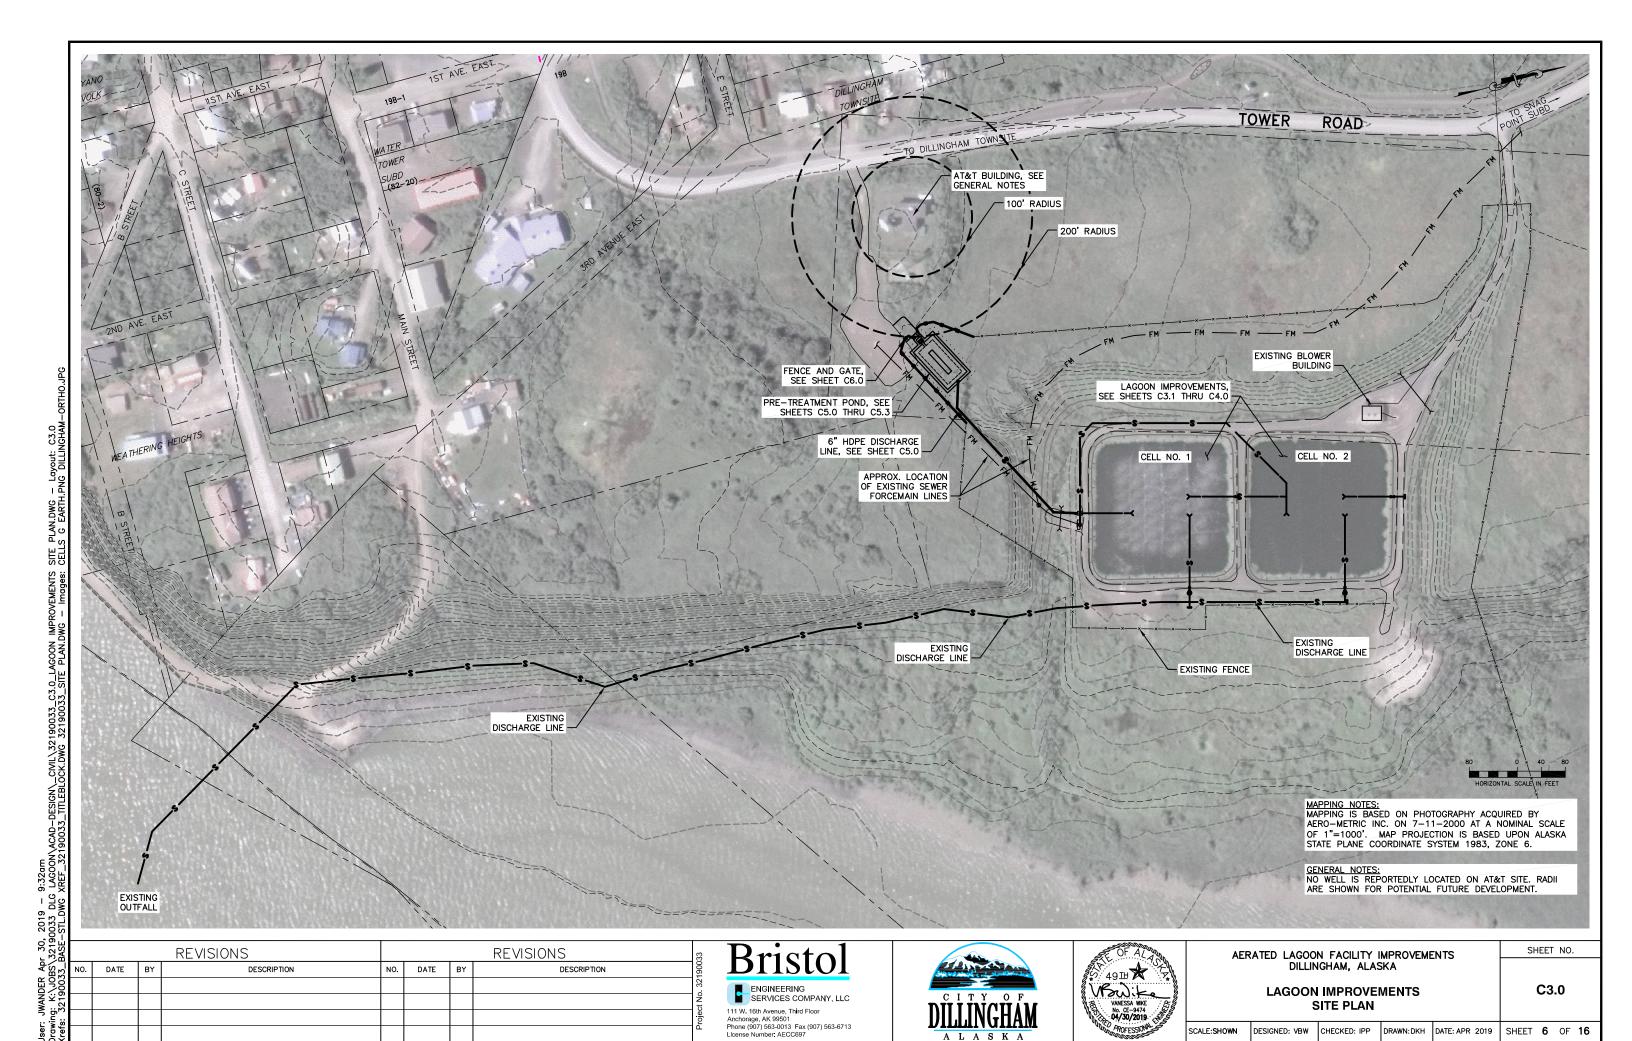
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AERATED LAGOON FACILITY IMPROVEMENTS DILLINGHAM, ALASKA


EQUAL. ANY ALTERNATE AERATION SYSTEM MUST INCLUDE REGULATORY APPROVAL,


WITHOUT LAYOUT APPROVAL FROM THE ONSITE ENGINEERING IN WRITING.

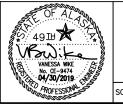LAGOON IMPROVEMENTS **AERATION SYSTEM LAYOUT PLAN AND SECTION** C3.1

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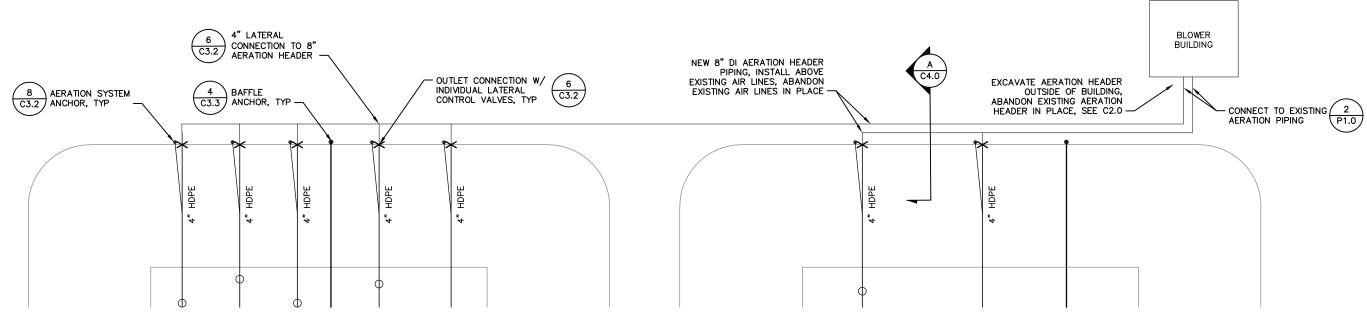


AERATED		FACILITY HAM, ALA	IMPROVEMENT SKA
LA	GOON II	MPROVE	MENTS
	BAFFL	E DETA	ILS

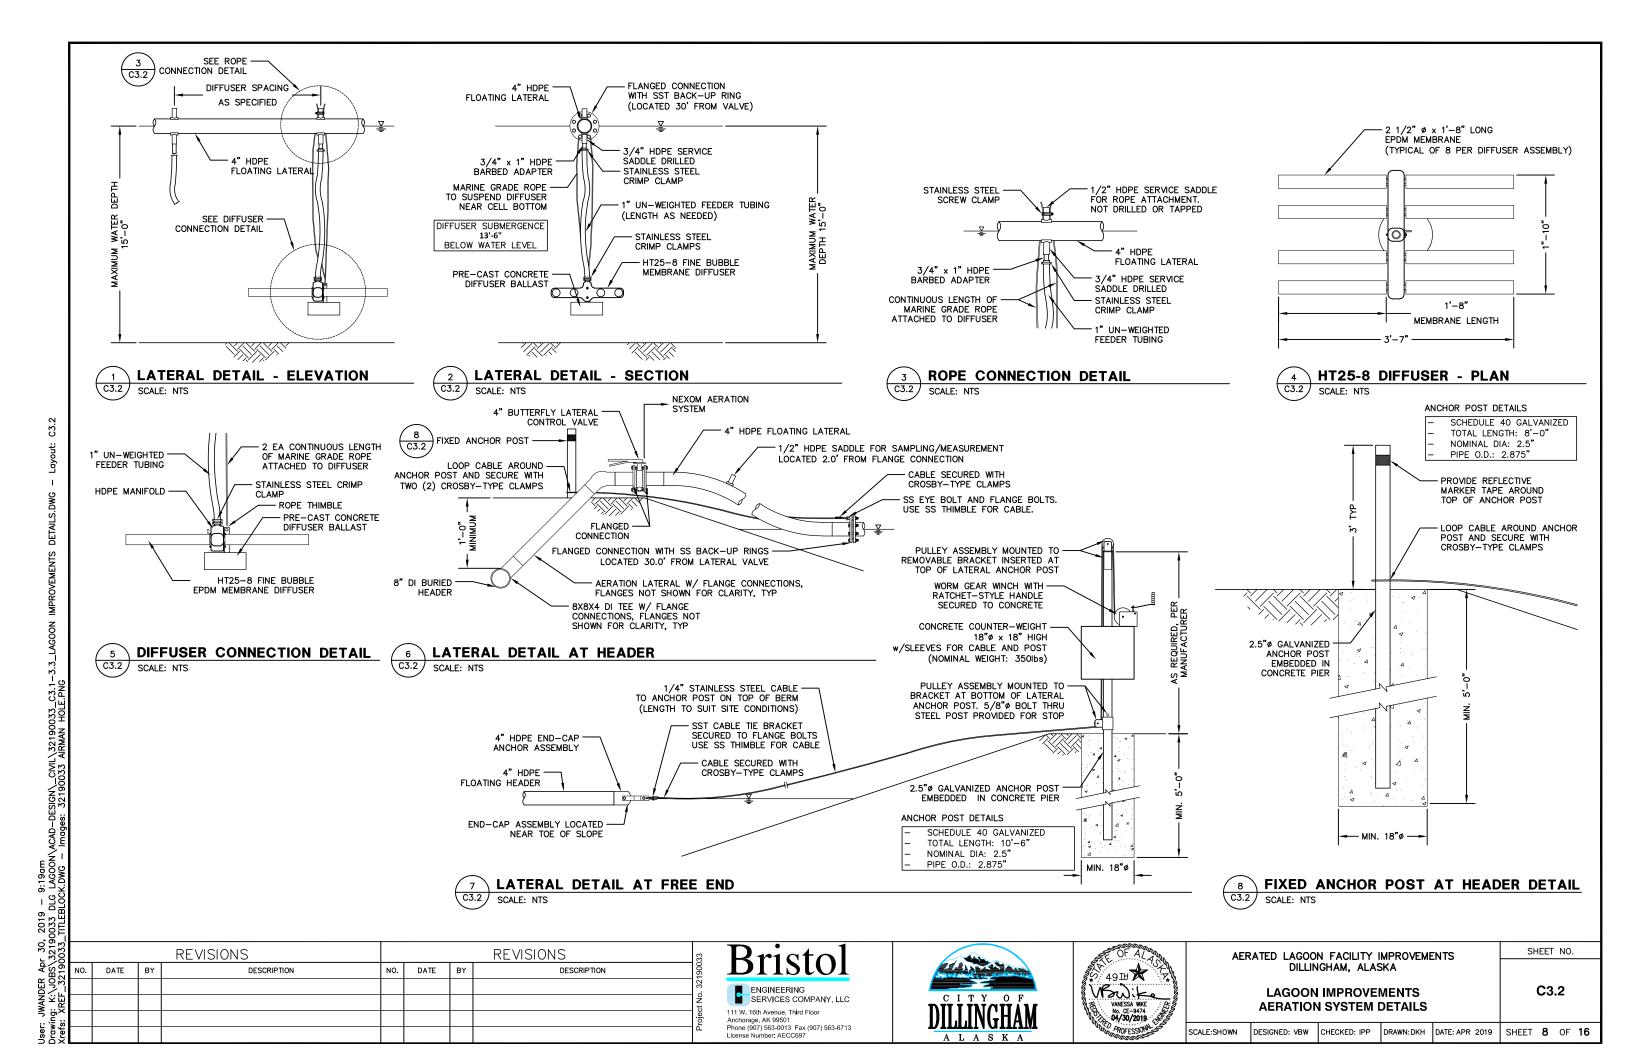C3.3
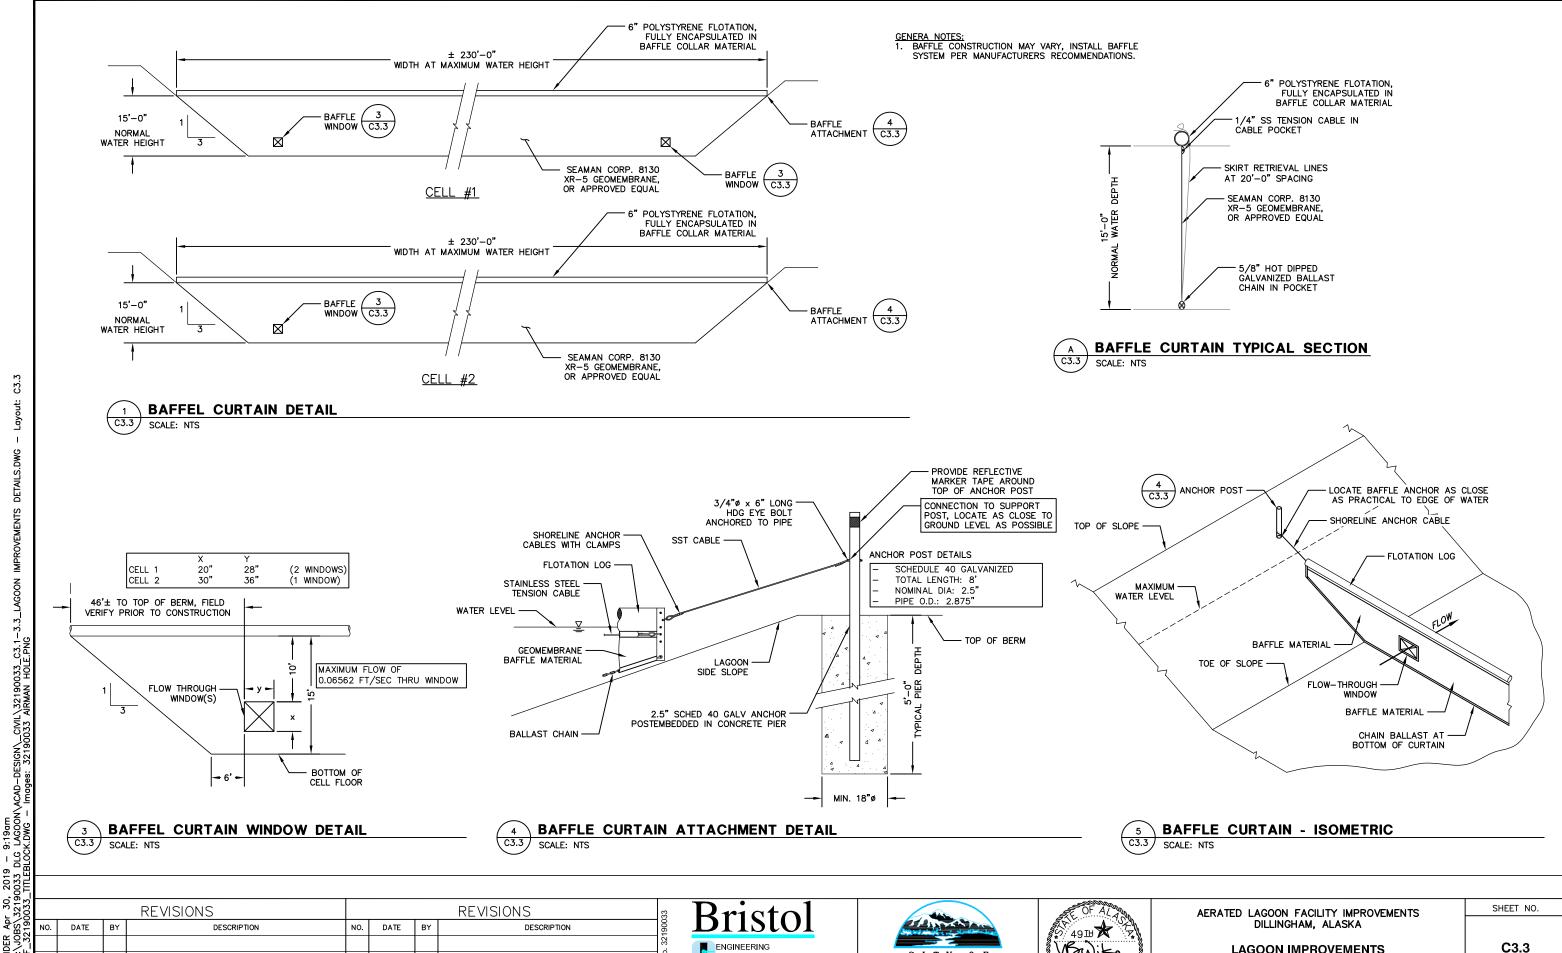
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AERATION HEADER PIPING PLAN C4.0 | SCALE: NTS DETECTABLE WARNING TAPE, INSTALL 6" C5.3 BELOW FINISHED GRADE SIMILAR - REPLACE EXISTING FILL NEW 8" DI AERATION HEADERS, INSTALL MIN. 6" ABOVE EXISTING HEADERS AND PROVIDE MIN. 1' COVER ABANDONED SEPTIC LINE EXISTING 8" DI AERATION

HEADERS, FIELD VERIFY LOCATION AND ABANDON IN PLACE

A AERATION SCALE: NTS **AERATION HEADER PIPING SECTION**

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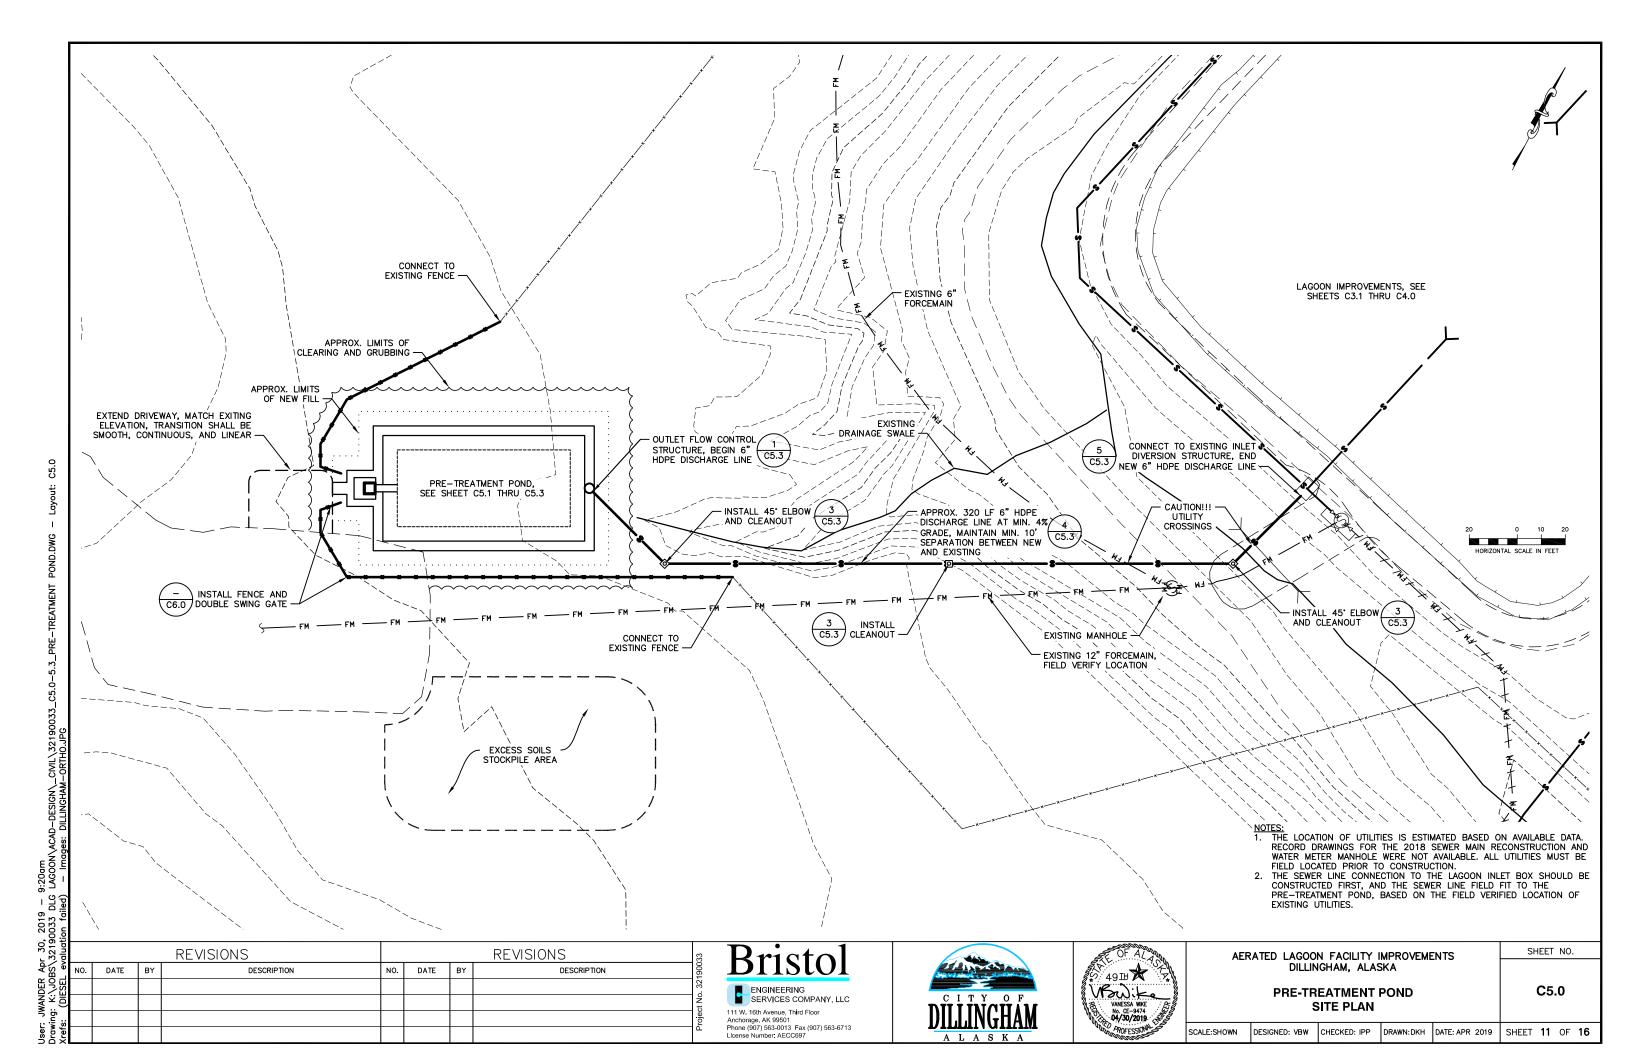



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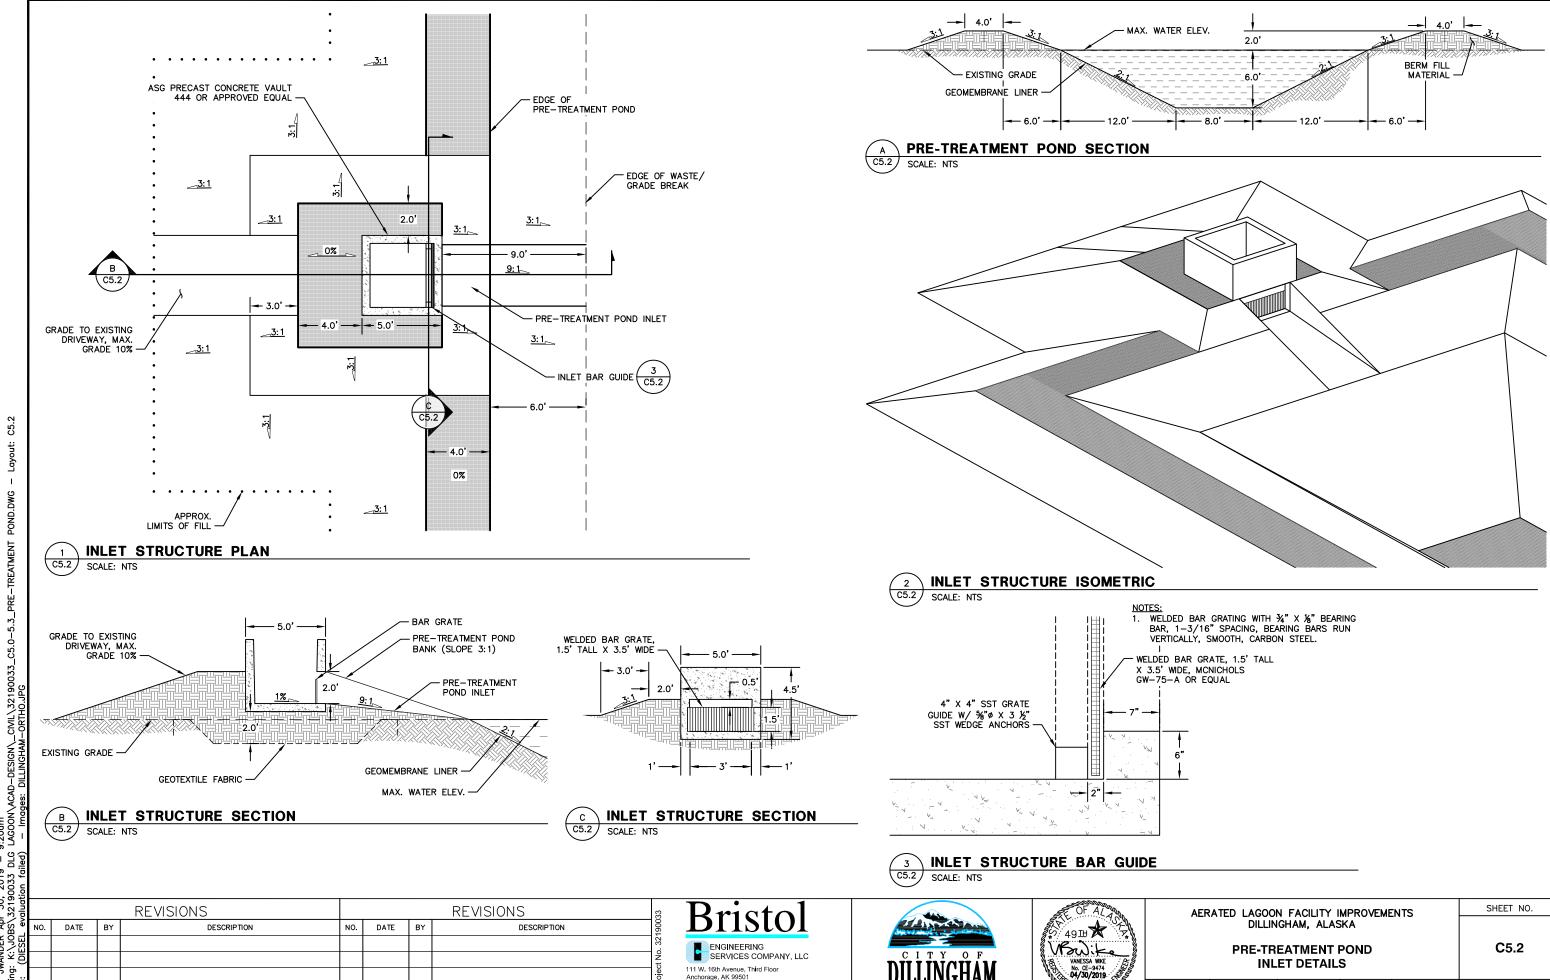
AERATED LAGOON FACILITY IMPROVEMENTS DILLINGHAM, ALASKA

LAGOON IMPROVEMENTS AERATION HEADER PLAN AND SECTION SHEET NO. C4.0

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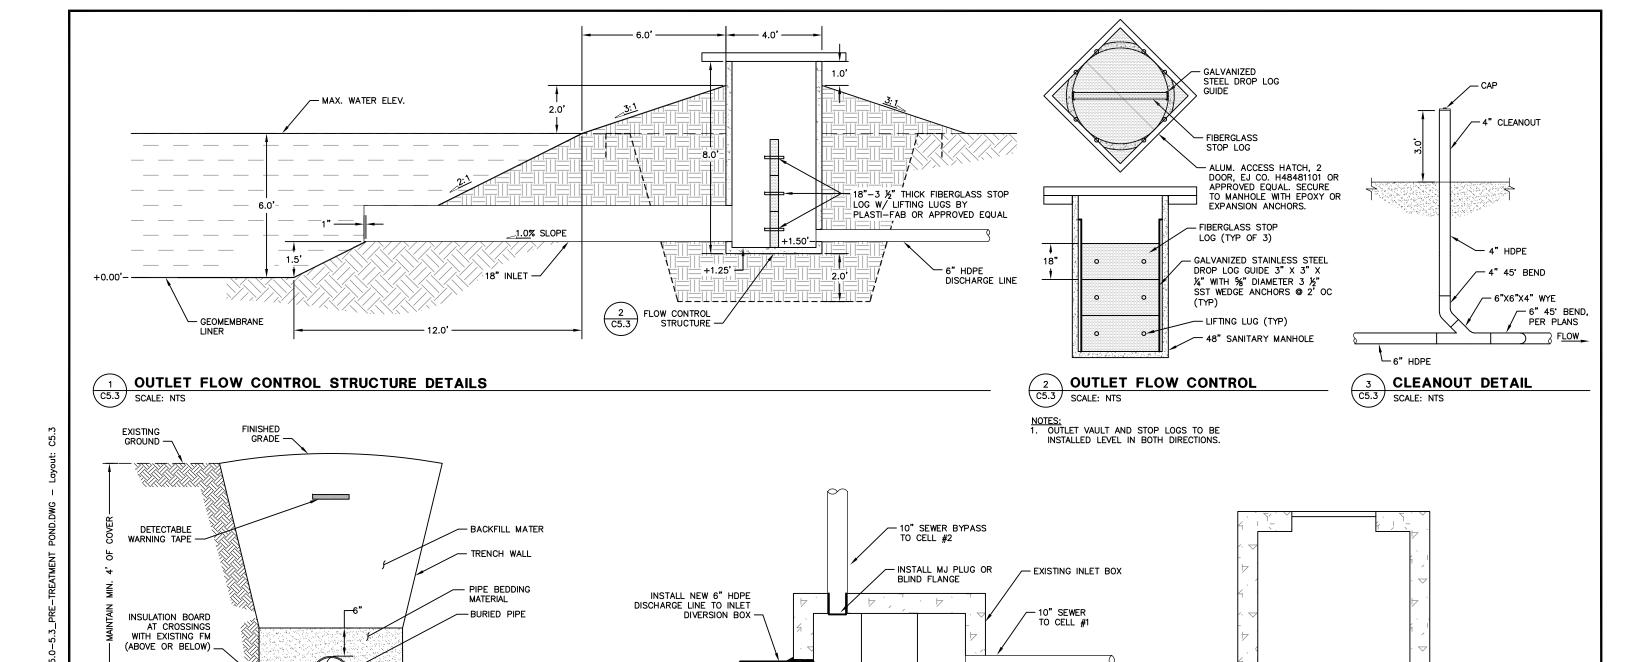
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User: JWANDER Apr 30, 2019 - 9:20am Drawing: K:\JOBS\32190033 DLG LAGOON\ACAD-DESIGN_CIVIL\3219(



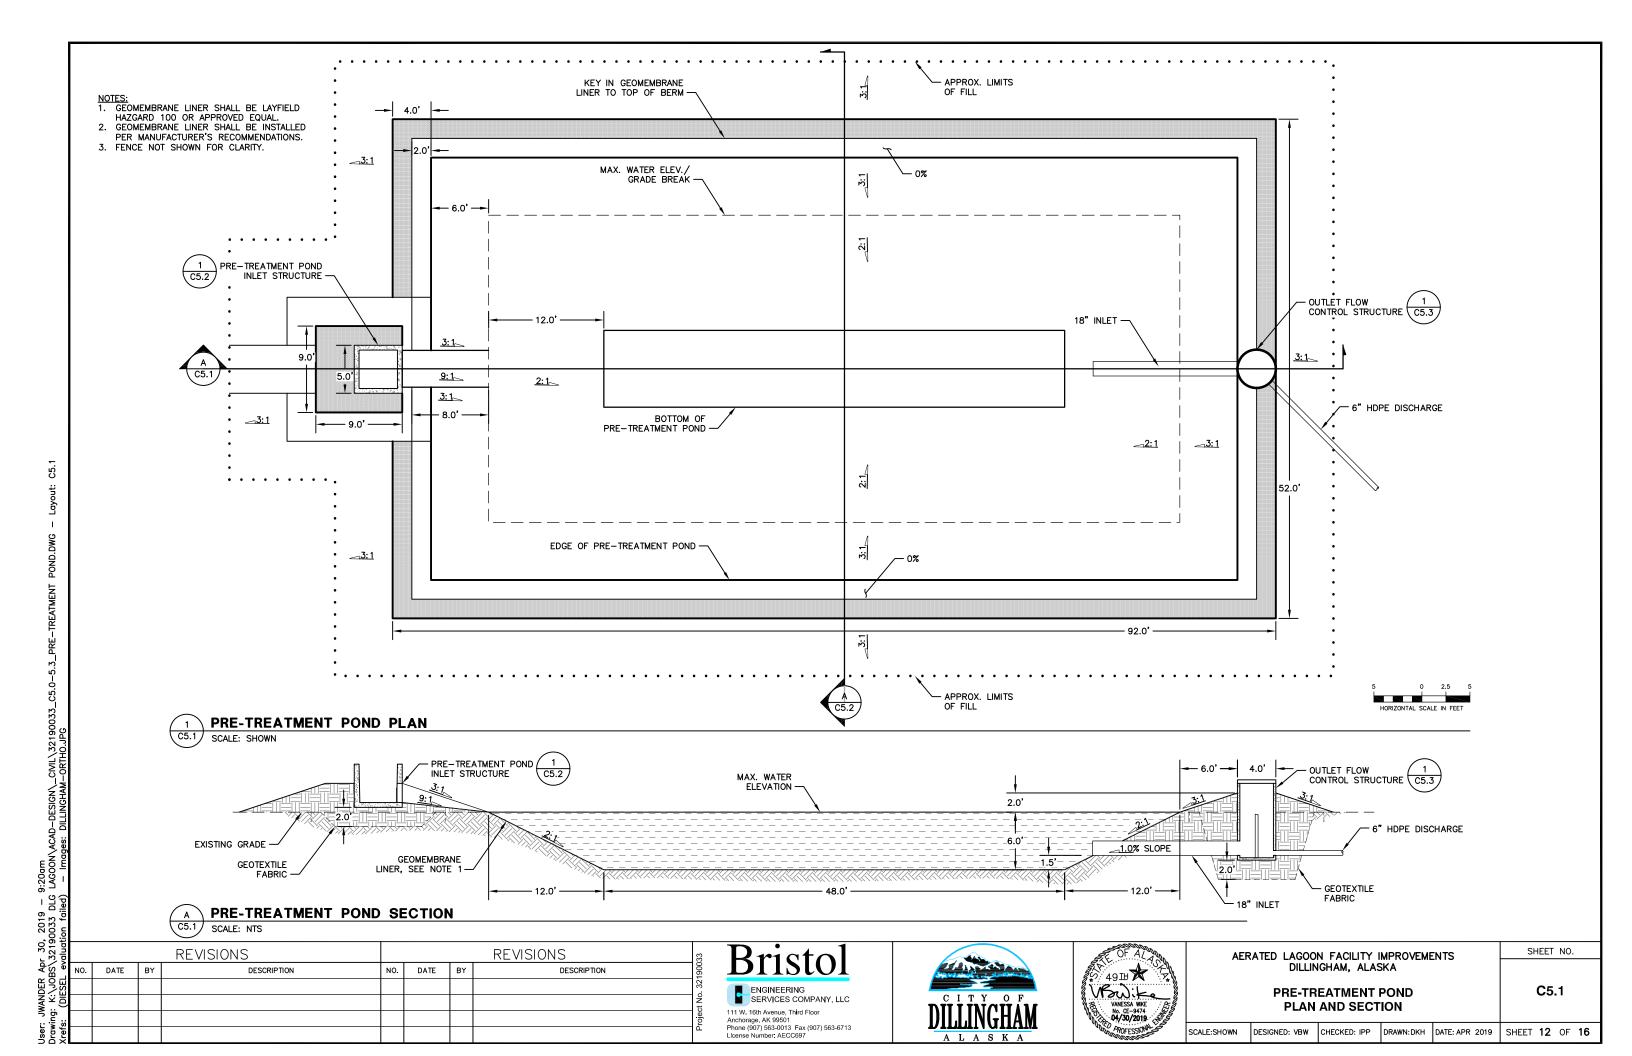

- 1. PIPE BEDDING MATERIAL SHALL BE A CLEAN WELL GRADED MATERIAL WITH A MAXIMUM PARTICLE SIZE OF 2" AND NOT MORE THAN 6% PASSING THE #200 SIEVE. MATERIAL SHALL BE COMPACTED TO 95% MDD IN TRAFFIC AREAS AND 90% ELSEWHERE.
- 2. TRENCH WALL SHALL BE SLOPED OR SHORED IN CONFORMANCE WITH ALL APPLICABLE SAFETY STANDARDS.
- 3. OVER EXCAVATE AND FILL WITH CLASSIFIED FILL IN AREAS OF ICE CONTENT OR PEAT. 4. INSURE THAT BEDDING MATERIAL IS PLACED AND CONSOLIDATED BELOW THE PIPE HAUNCHES.

TYPICAL TRENCH SECTION C5.3 SCALE: NTS

UNDISTURBED

INORGANIC SOIL-

CONNECTION TO EXISTING LAGOON INLET STRUCTURE

TOP VIEW

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WOOD STOPS

(TO BE REMOVED) -

NON-SHRINK GROUT





INSTALL NEW 6" HDPE DISCHARGE LINE TO INLET

ELEV.=36.25

AERATED	 FACILITY HAM, ALA	IMPROVEMENTS ASKA

10" BYPASS

TO CELL #2

SIDE VIEW

ELEV.=35.75

PRE-TREATMENT POND **OUTLET AND DISCHARGE LINE DETAILS**

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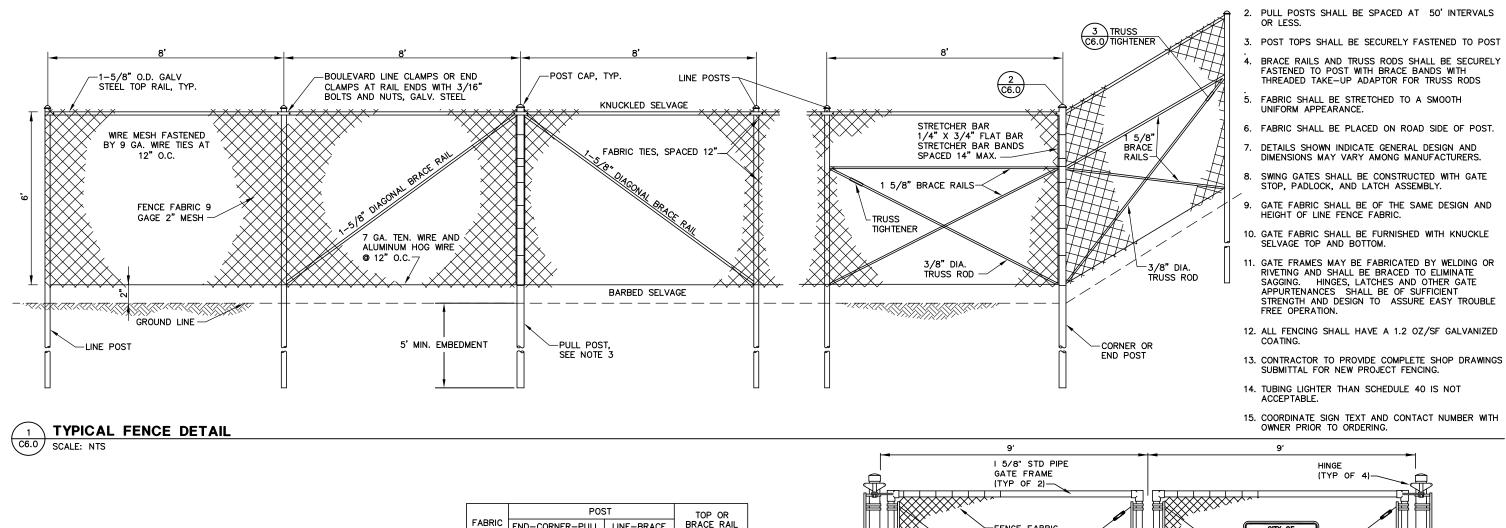
- 10" RAW SEWAGE


TO CELL #1

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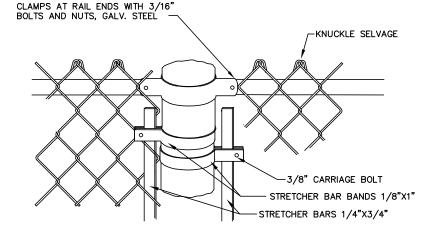
10" INFLUENT

FORCEMAIN SEWER



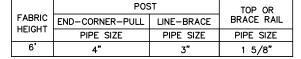


ALL PIPES SHALL BE SCH 40 ASTM F1083 E>30,000 PSI



END - CORNER - PULL \setminus POST TOP DETAIL C6.0 | SCALE: NTS

BOULEVARD LINE CLAMPS OR END

TRUSS ROD DETAIL SCALE: NTS

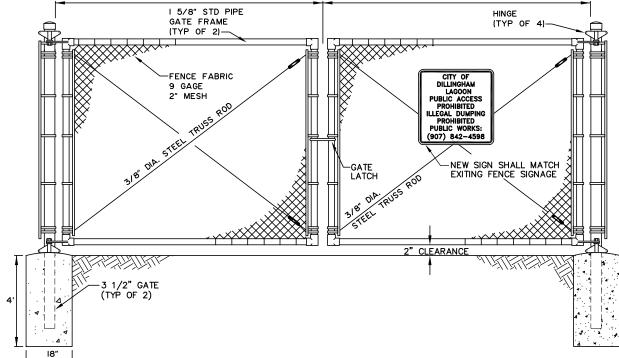


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C6.0 | SCALE: NTS



DOUBLE SWING GATE DETAIL

AERATED LAGOON FACILITY IMPROVEMENTS DILLINGHAM, ALASKA FENCE DETAILS

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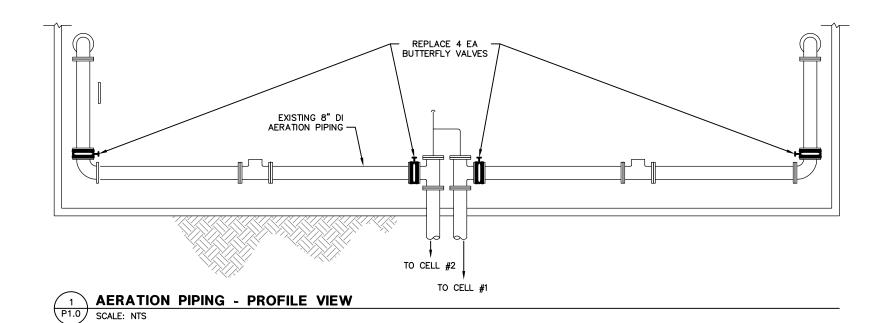
FENCE NOTES:

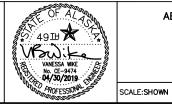
1. POSTS SHALL BE DRIVEN OR AUGURED AS SHOWN.

DESIGNED: VBW

C6.0

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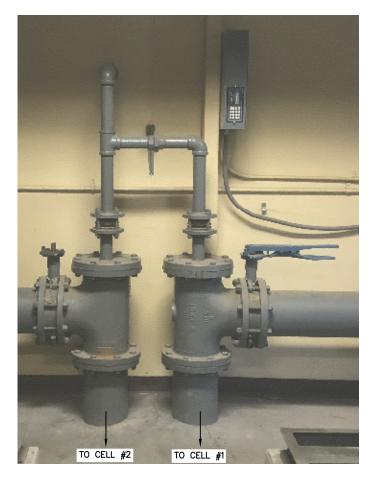


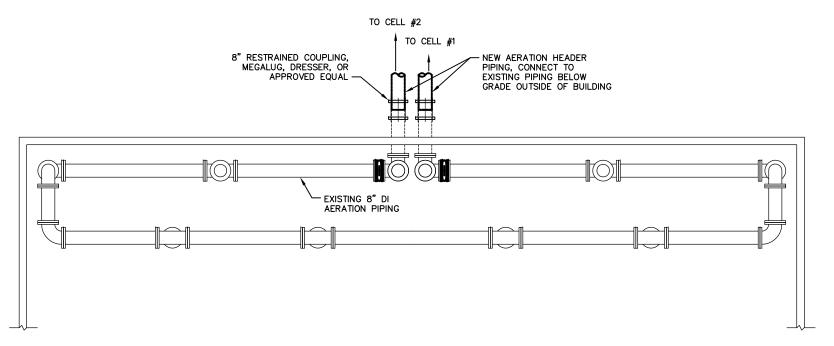

2 AERATIC P1.0 SCALE: NTS **AERATION PIPING - PLAN VIEW**

NOTES:

1. BUTTERFLY VALVES SHALL BE LUG STYLE WITH EPOXY COATED DUCTILE IRON BODY, EPDM SEAT SECURELY KEYED INTO THE BODY, ALUMINUM BRONZE DISC, STAINLESS STEEL STEM, DUAL PTFE STEM BEARINGS, LEVER OPERATOR WITH LOCKABLE HANDLE. 150 PSI RATING. NIBCOLD—2000, FNW FIG 712, OR EQUAL.




3 EXISTING BUTTERFLY VALVES
P1.0 SCALE: NTS

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AERATED LAGOON FACILITY IMPROVEMENTS DILLINGHAM, ALASKA

BLOWER BUILDING

SHEET NO.

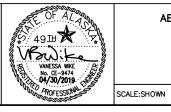P1.0

VALVE REPLACEMENT DETAILS

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